

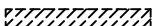


WALL KEY

-  EXISTING WALL
-  NEW WALL CONSTRUCTION
-  DEMO EXISTING WALL



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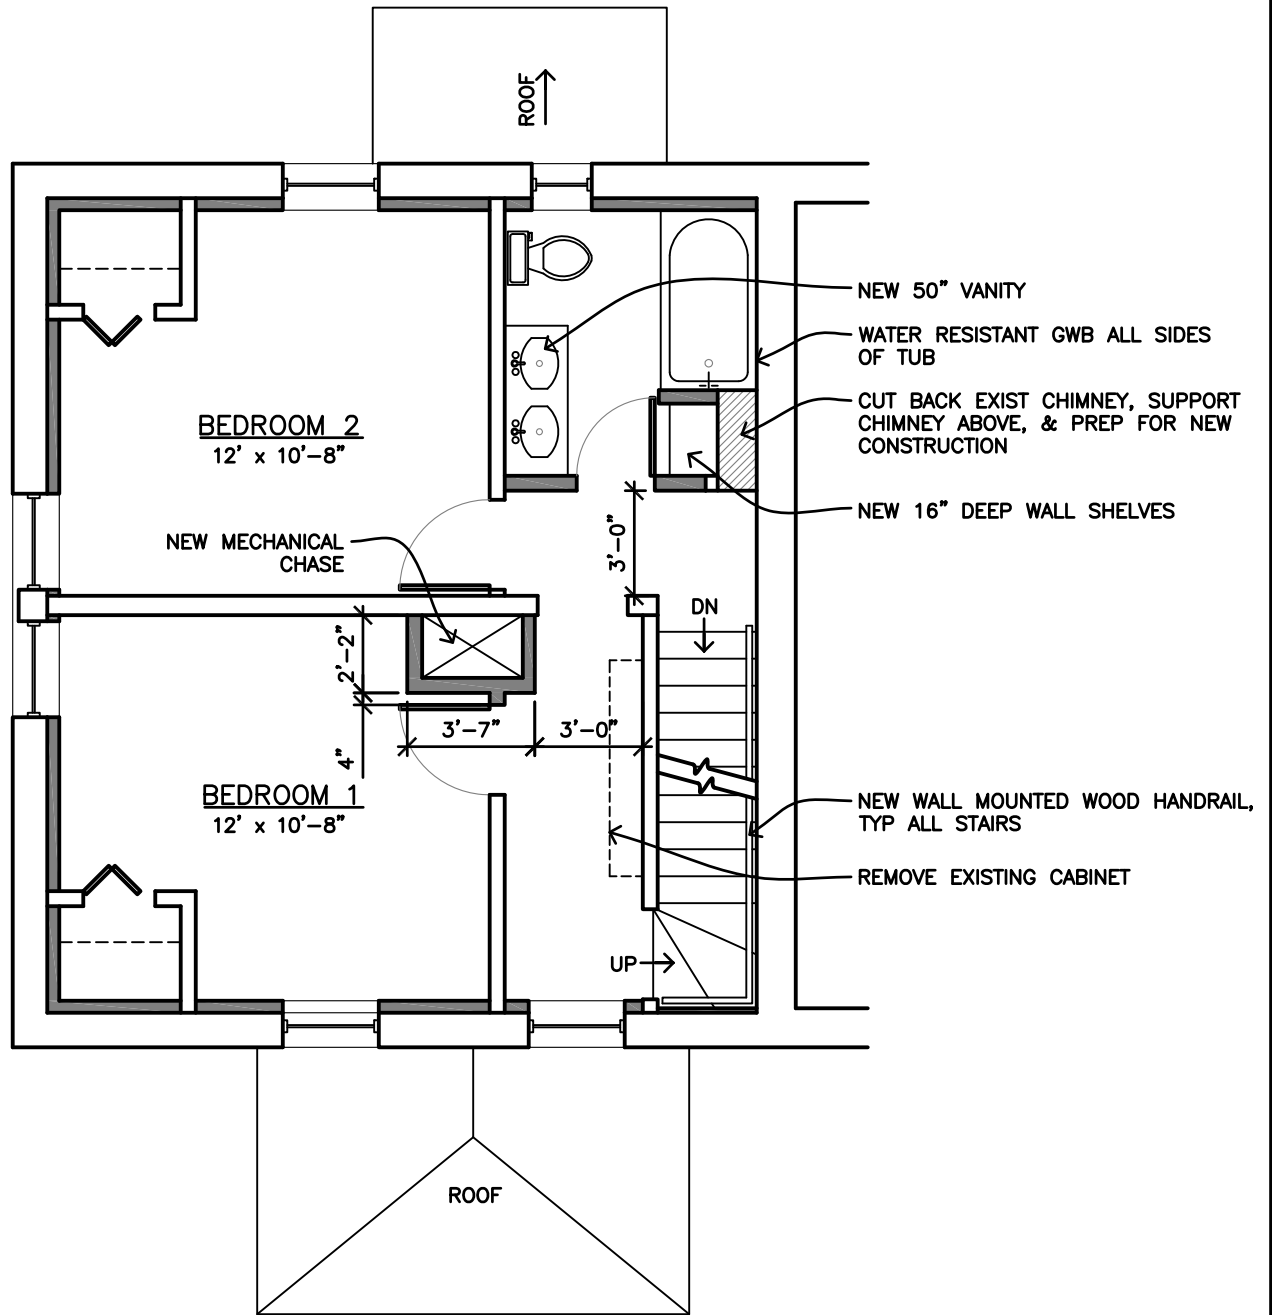
FIRST FLOOR PLAN

SCALE:
3/16" = 1'-0"

DATE:
9/6/11

SHEET NO.

A2



WALL KEY

	EXISTING WALL
	NEW WALL CONSTRUCTION
	DEMO EXISTING WALL



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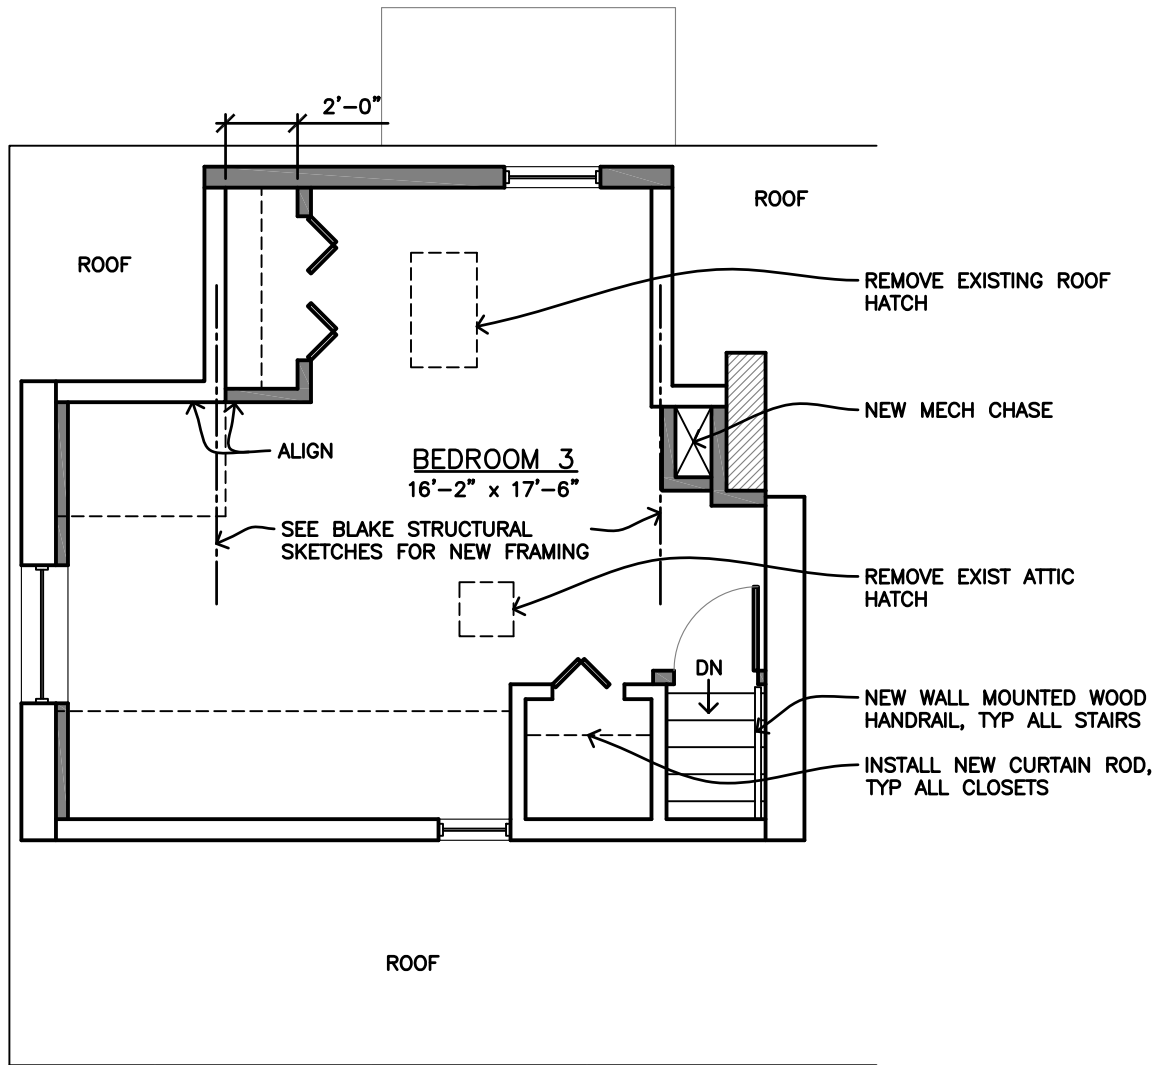
1 BROADSHIP RD
DUNDALK, MD 21222

SECOND FLOOR PLAN




SCALE:
3/16" = 1'-0"

DATE:
9/6/11

SHEET NO.
A3



- NOTES:**
1. SEE BLAKE STRUCTURAL SKETCHES FOR NEW 3RD FLOOR FRAMING PLANS
 2. R-38 FBGLS BATT INSUL IN ATTIC JOISTS.
 3. R-19 FBGLS BATT INSUL IN ALL KNEE WALLS, SLOPED WALLS, & VERTICAL WALLS.
 4. ATTIC VENTILATION TO BE COORDINATED W/ ARCHITECT.

WALL KEY	
	EXISTING WALL
	NEW WALL CONSTRUCTION
	DEMO EXISTING WALL



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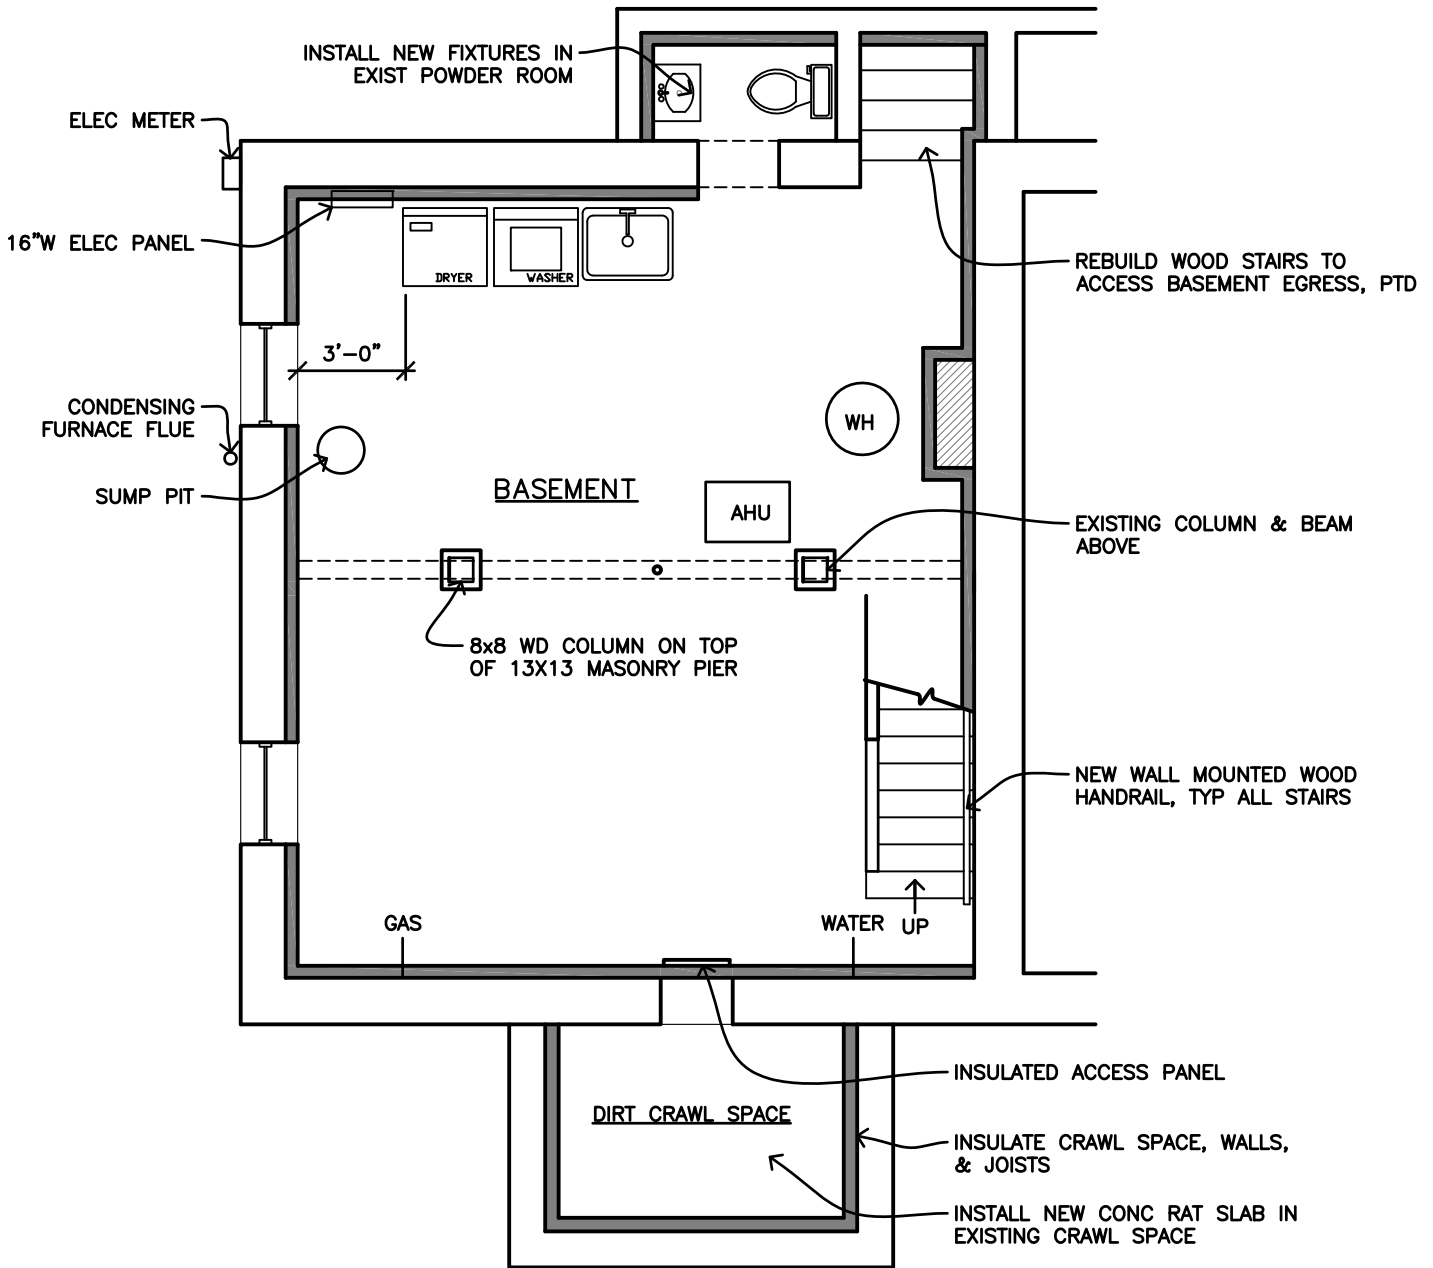
THIRD FLOOR PLAN

SCALE:
3/16" = 1'-0"




DATE:
9/6/11

SHEET NO.

A4



NOTES:
 1. OWNER TO EVALUATE INSTALLATION OF BASEMENT WALL PARTITION. INSTRUCT CONTRACTOR FOR LOCATION

WALL KEY	
	EXISTING WALL
	NEW WALL CONSTRUCTION
	DEMO EXISTING WALL



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BASEMENT PLAN

SCALE:
 3/16" = 1'-0"

DATE:
 9/6/11

SHEET NO.

A1